


PROPOSED DUPLEX 50 PROCTOR PARADE, CHESTER HILL NSW 2162

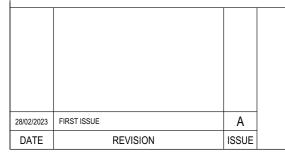

PROJECT NAME :

Proposed Duplex

DRAWING TITLE :

Elevation Front With Shadows

DRAWN BY: JW

CHECKED BY: LC

CLIENT NAME: Tinh Dang

SITE DETAILS:

50 Proctor Parade, Chester Hill NSW

SITE AREA: 605.8 m sq

ZONE: R2

PLOT DATE: 28/02/2023


PROJECT NO: 5727

SOFTWARE: ArchiCad V 24

ISSUE:

SHEET NO: 1 of 15



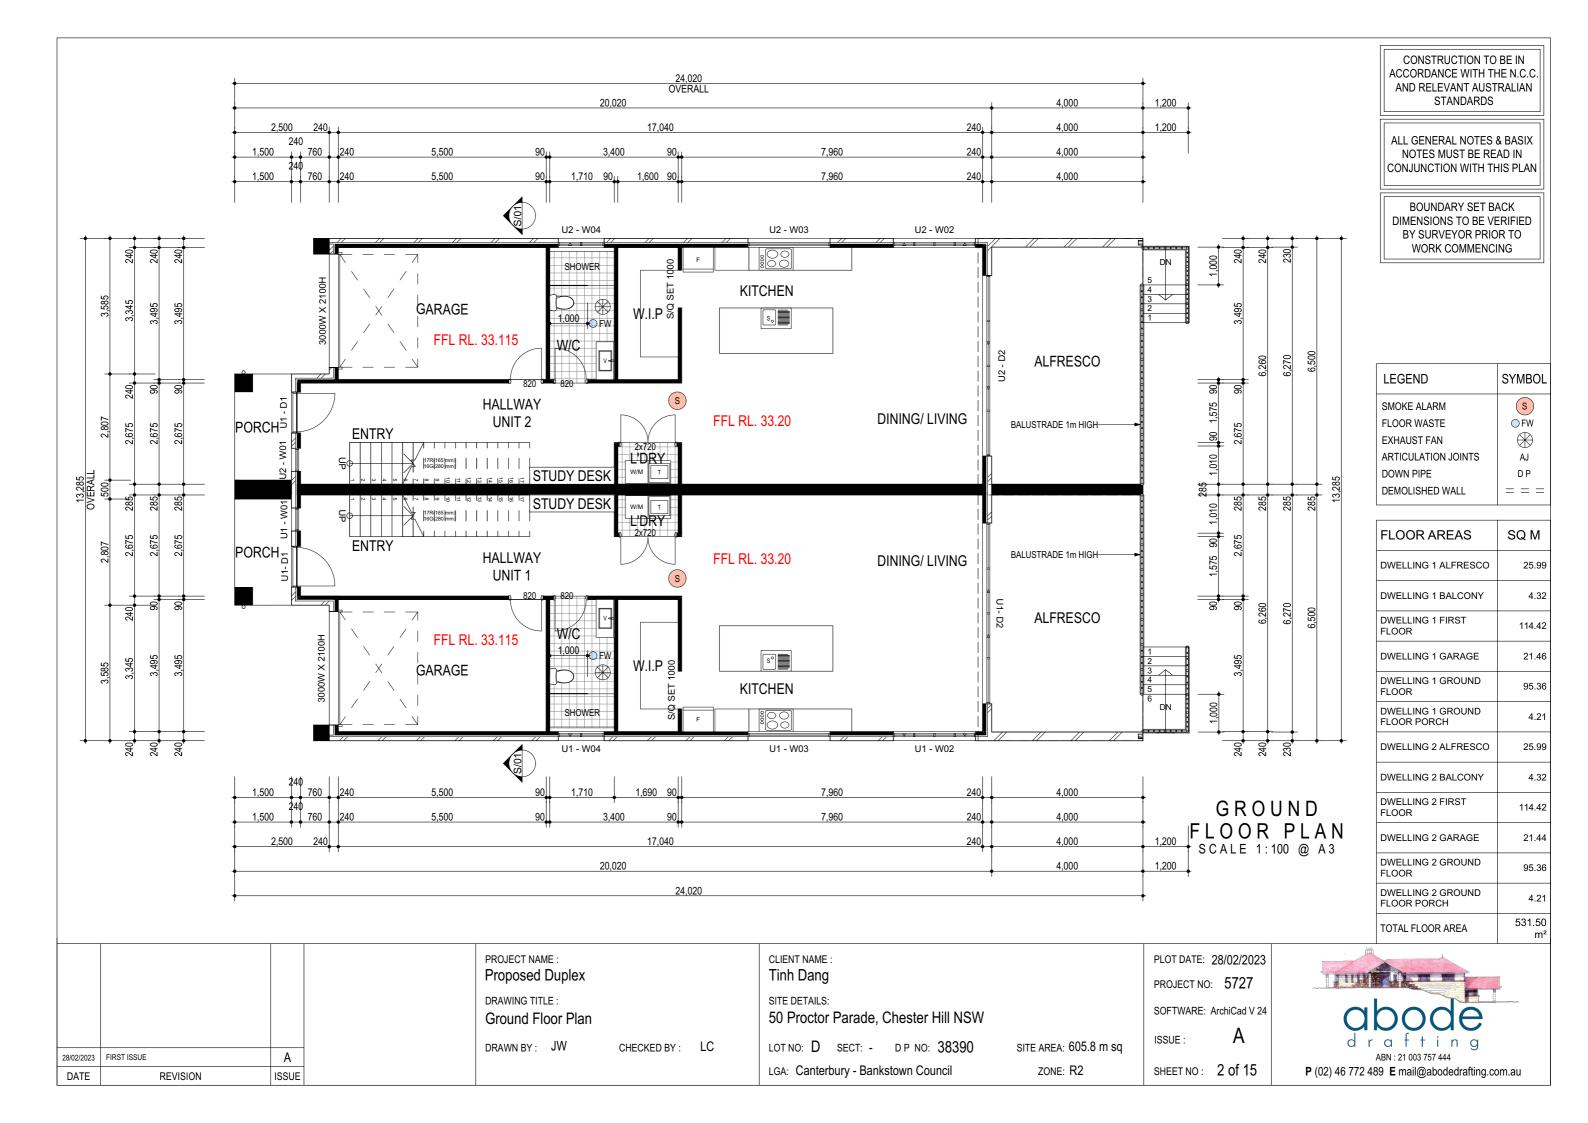



CHECKED BY: LC

First Floor Plan

DRAWN BY: JW

28/02/2023 | FIRST ISSUE

REVISION

DATE

Α

ISSUE

CONSTRUCTION TO BE IN ACCORDANCE WITH THE N.C.C. AND RELEVANT AUSTRALIAN STANDARDS

ALL GENERAL NOTES & BASIX NOTES MUST BE READ IN CONJUNCTION WITH THIS PLAN

BOUNDARY SET BACK DIMENSIONS TO BE VERIFIED BY SURVEYOR PRIOR TO WORK COMMENCING

LEGEND	SYMBOL	
SMOKE ALARM	S	
FLOOR WASTE	○FW	
EXHAUST FAN	\otimes	
ARTICULATION JOINTS	AJ	
DOWN PIPE	DP	
DEMOLISHED WALL	= = =	

FLOOR AREAS	SQ M
DWELLING 1 ALFRESCO	25.99
DWELLING 1 BALCONY	4.32
DWELLING 1 FIRST FLOOR	114.42
DWELLING 1 GARAGE	21.46
DWELLING 1 GROUND FLOOR	95.36
DWELLING 1 GROUND FLOOR PORCH	4.21
DWELLING 2 ALFRESCO	25.99
DWELLING 2 BALCONY	4.32
DWELLING 2 FIRST FLOOR	114.42
DWELLING 2 GARAGE	21.44
DWELLING 2 GROUND FLOOR	95.36
DWELLING 2 GROUND FLOOR PORCH	4.21
TOTAL FLOOR AREA	531.50 m²

PLOT DATE: 28/02/2023 PROJECT NO: 5727 SOFTWARE: ArchiCad V 24

ISSUE:

SITE AREA: 605.8 m sq

ZONE: R2

50 Proctor Parade, Chester Hill NSW


LOT NO: D SECT: - DP NO: 38390

LGA: Canterbury - Bankstown Council

SHEET NO: 3 of 15



SARKING & INSULATION TO BASIX & BCA TO UNDERSIDE OF ROOF SHEETING

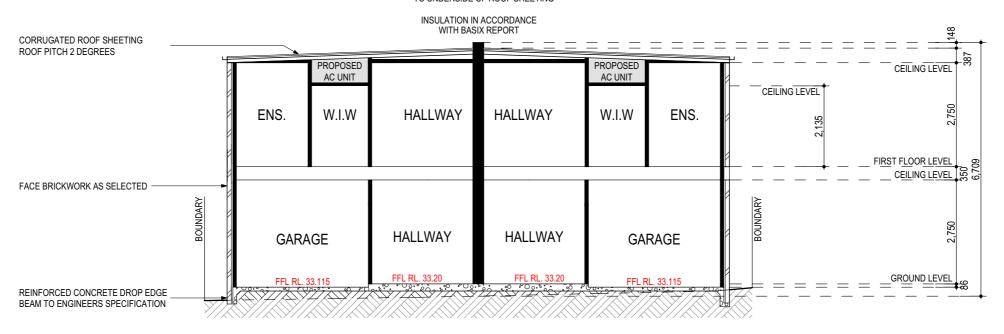

SECTION S/01 SCALE 1:100 @ A3

DOOR SCHEDULE						
ID	Door Type/Code	Height	Width	Plan View	Elev. View	Wall Structure
U1 - D1	AA	2,143	1,080			240mm Brick Veneer - Clear
U1- D1	AA	2,143	1,080			240mm Brick Veneer - Clear
U1- D2	AA	2,100	4,780		← →	240mm Brick Veneer - Clear
U1- D3	AA	2,400	2,410		\rightarrow	240mm Brick Veneer - Clear
U2 - D2	AA	2,100	4,780		\leftarrow \rightarrow	240mm Brick Veneer - Clear
U2 - D3	AA	2,400	2,410		←	240mm Brick Veneer - Clear

	WΙ	N D	O W	SCHE	DULE				WΙ
ID	Window Code	Height	Width	Plan View	Elev. View	Header Height		U2 - W01	AA
U1 - W01	AA	2,143	610	F		2,143		U2 - W02	AA
U1 - W02	AA	1,460	2,170			2,143		U2 - W03	AA
U1 - W03	AA	600	2,170			1,543		U2 - W04	AA
U1 - W04	AA	1,460	1,210			2,143		U2 - W05	AA
U1 - W05	AA	1,460	1,570			2,400		U2 - W06	AA
U1 - W06	AA	600	2,170			2,143		U2 - W08	AA
U1 - W07	AA	600	2,170			2,143		U2 - W09	AA
U1 - W08	AA	600	2,170			2,143		U2 - W10	AA
U1 - W09	AA	600	850			2,143		U2 - W11	AA
U1 - W10	AA	600	850			2,143		U2 - W 07	AA
U1 - W11	AA	1,460	2,170			2,143			
						PLOT	DATE	∷ 28/	02/2023

	WINDOW SCHEDULE					
J2 - V01	AA	2,143	610			2,143
J2 - V02	AA	1,460	2,170			2,143
J2 - V03	AA	600	2,170			1,543
J2 - V04	AA	1,460	1,210			2,143
J2 - V05	AA	1,460	1,570			2,400
J2 - V06	AA	600	2,170			2,143
J2 - V08	AA	600	2,170			2,143
J2 - V09	AA	600	850			2,143
J2 - V10	AA	600	850			2,143
J2 - V11	AA	1,460	2,170			2,143
J2 - W 07	AA	600	2,170			2,143

28/02/2023	FIRST ISSUE		Α	
DATE		REVISION	ISSUE	

PROJECT NAME :
Proposed Duplex

DRAWING TITLE:

Section, Door & Window Schedule

DRAWN BY: JW

CHECKED BY: LC

CLIENT NAME: Tinh Dang

SITE DETAILS:

50 Proctor Parade, Chester Hill NSW

LOT NO: D SECT: - DP NO: 38390 LGA: Canterbury - Bankstown Council

SITE AREA: 605.8 m sq

ZONE: R2


SHEET NO: 4 of 15


ISSUE:

PROJECT NO: 5727


SOFTWARE: ArchiCad V 24



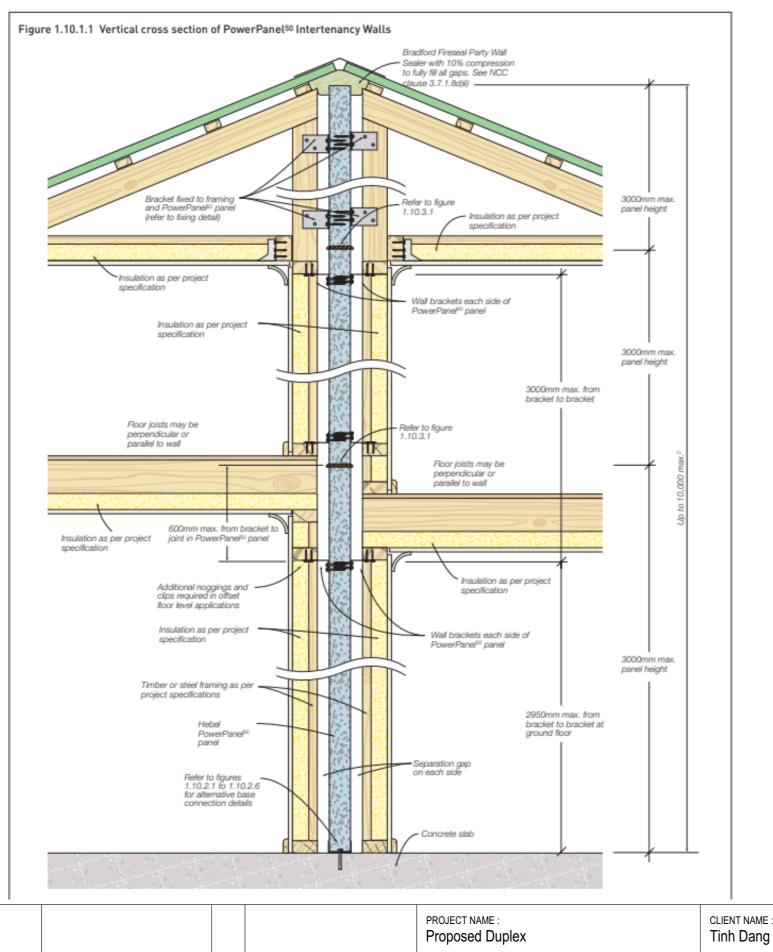

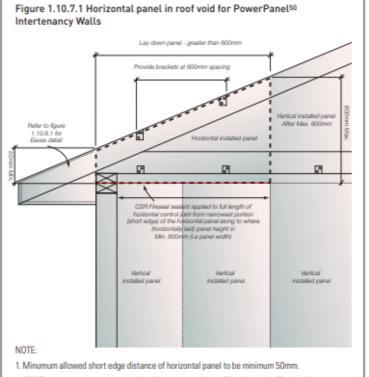


- 2. CSR Fire sealant applied to one side of the joint to achieve FRL of -/60/60 (Refer to figure 1.10.3.5)
- 3. CSR Fire sealant applied to both sides of the joint to achieve FRL of -/90/90 FRL (Refer to Figure 1.10.3.6)

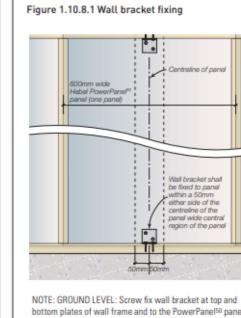

bottom plates of wall frame and to the PowerPanel50 panel. No brackets are required at bottom plate when using a continuous deflection head track or continuous steel angle for

UPPER LEVEL: Screw fix wall bracket at top and bottom plates of wall frame and to the PowerPanel50 panel.

Wall brackets are screw fixed to PowerPanel50 panel at 600mm centres, within 50mm either side of centreline of each panel. Use fixings specified in Table 1.3.5.

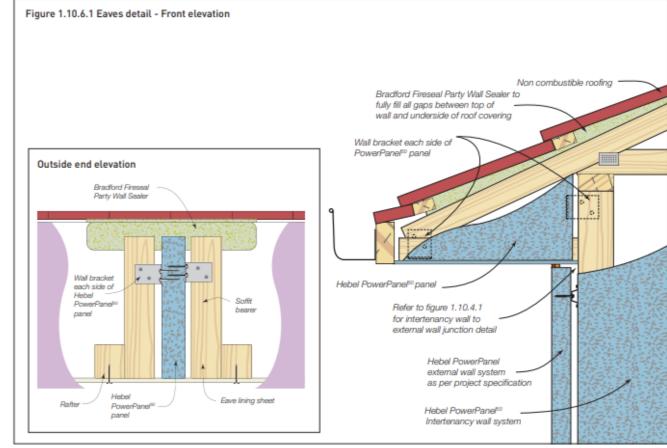

PLOT DATE: 28/02/2023

SOFTWARE: ArchiCad V 24

PROJECT NO: 5727

28/02/2023 FIRST ISSUE Α DATE REVISION ISSUE

DRAWING TITLE:

Intertenancy Wall Details

DRAWN BY: JW CHECKED BY: LC CLIENT NAME:

SITE DETAILS:

50 Proctor Parade, Chester Hill NSW


LOT NO: D SECT: - DP NO: 38390 LGA: Canterbury - Bankstown Council

SITE AREA: 605.8 m sq

ZONE: R2 SHEET NO: 5 of 15


ISSUE:



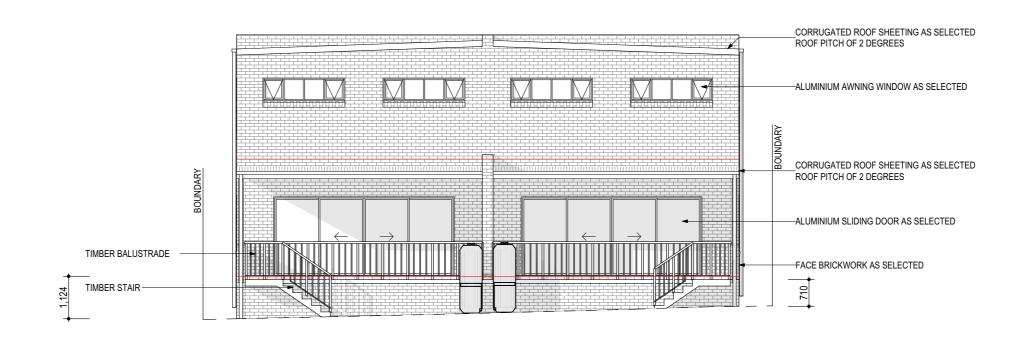


NORTHERN ELEVATION

SCALE 1:100 @ A3

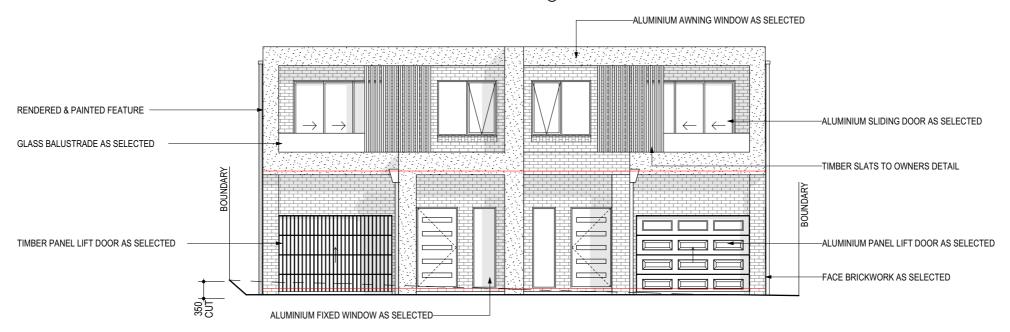


SOUTHERN ELEVATION SCALE 1:100 @ A3

			PROJECT NAME : Proposed Duplex	CLIENT NAME : Tinh Dang	PLOT DATE: 28/02/2023 PROJECT NO: 5727	
			DRAWING TITLE : Elevations	site DETAILS: 50 Proctor Parade, Chester Hill NSW	SOFTWARE: ArchiCad V 24	abode
28/02/2023	FIRST ISSUE	Δ	DRAWN BY: JW CHECKED BY: LC	LOT NO: D SECT: - DP NO: 38390 SITE AREA: 605.8 m sq	ISSUE: A	drafting ABN: 21 003 757 444
DATE		ISSUE		LGA: Canterbury - Bankstown Council ZONE: R2	SHEET NO: 6 of 15	P (02) 46 772 489 E mail@abodedrafting.com.au

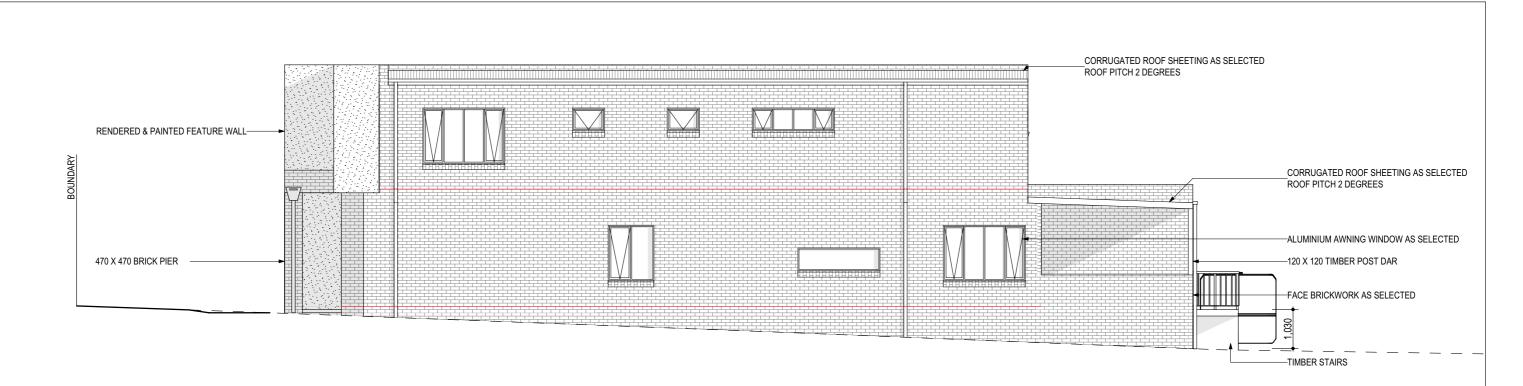


EASTERN ELEVATION


SCALE 1:100 @ A3

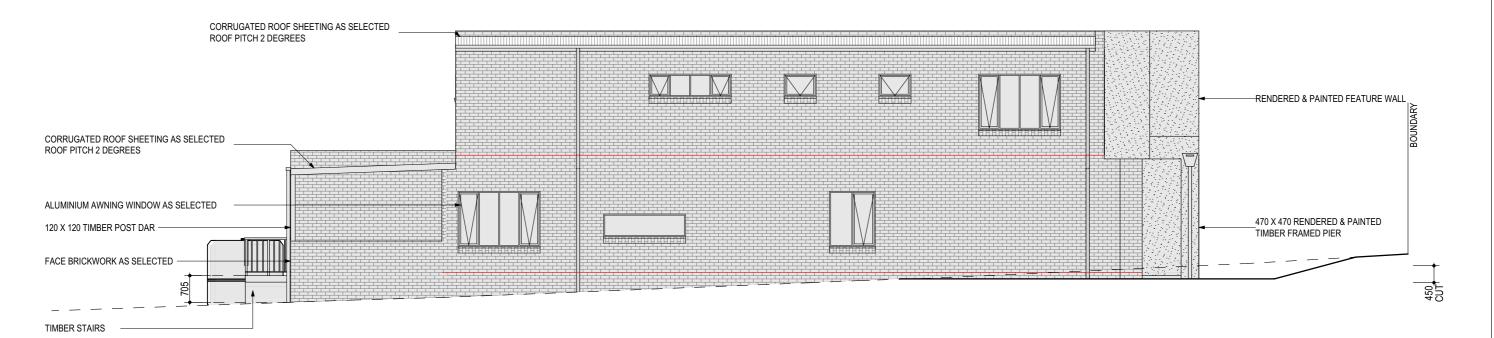


WESTERN ELEVATION

SCALE 1:100 @ A3

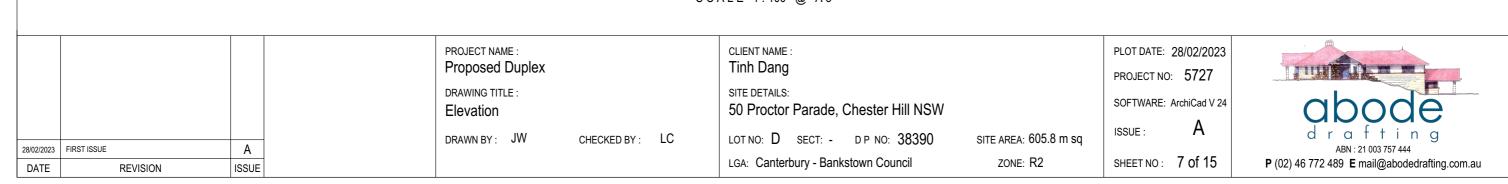

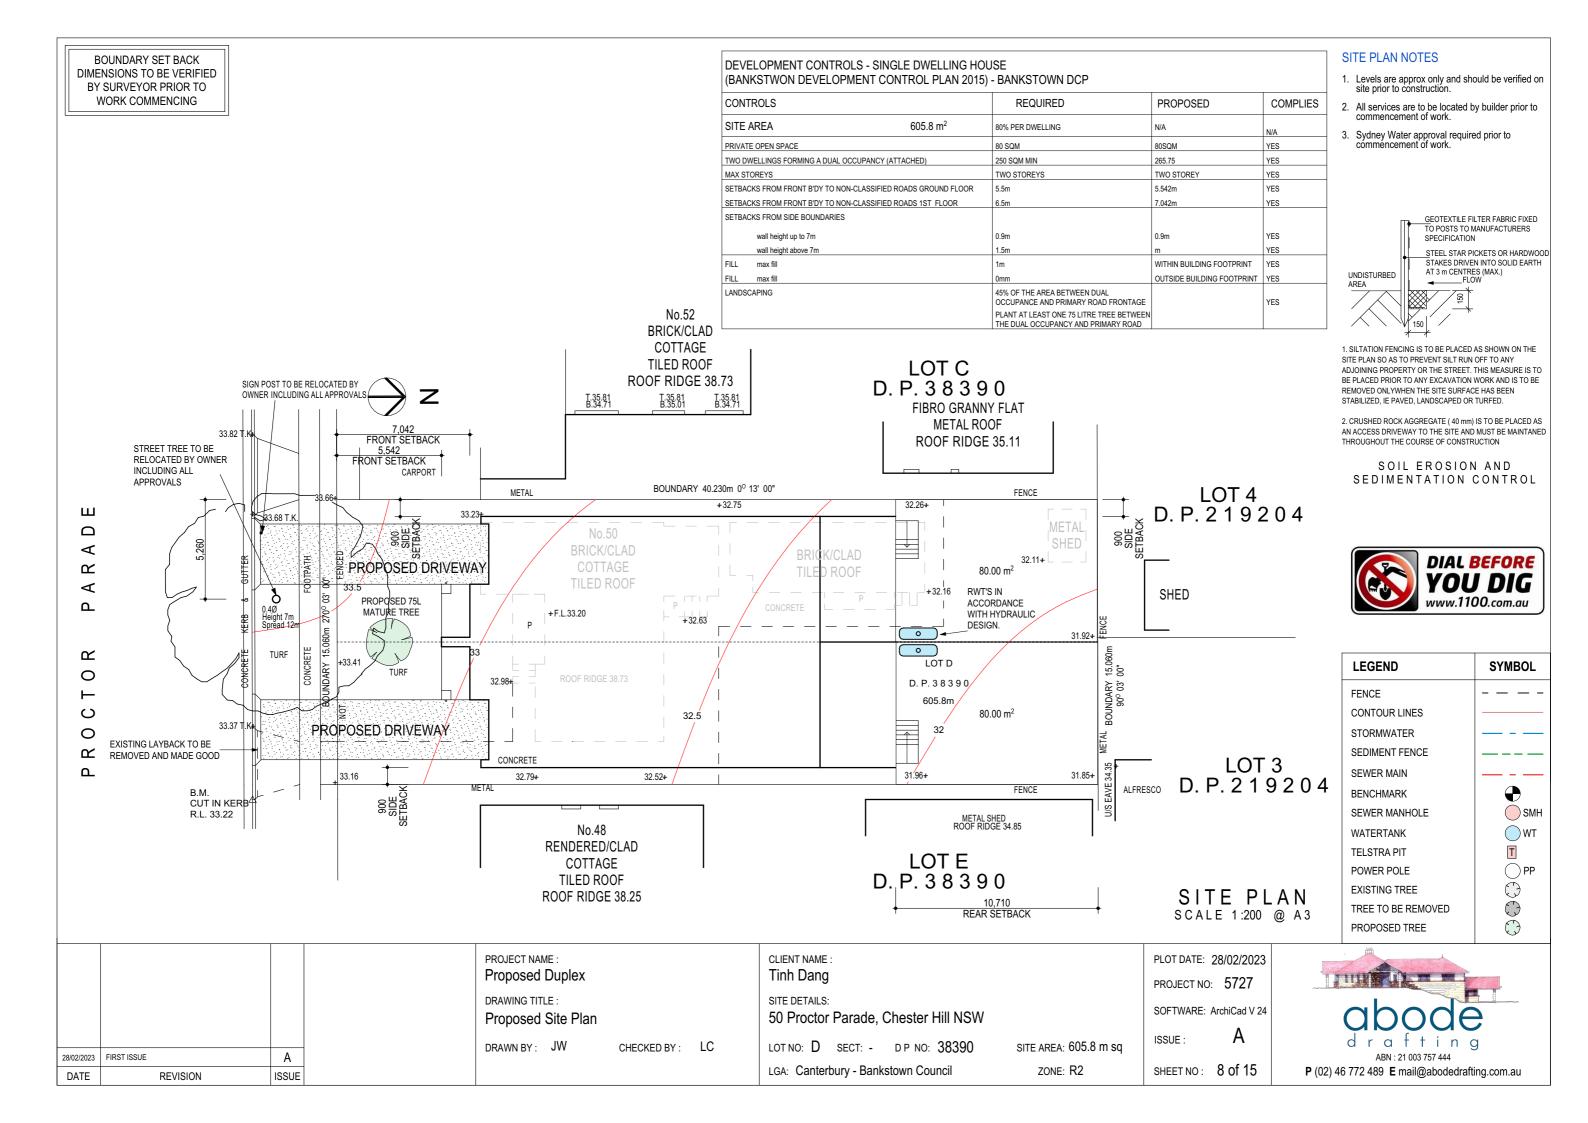

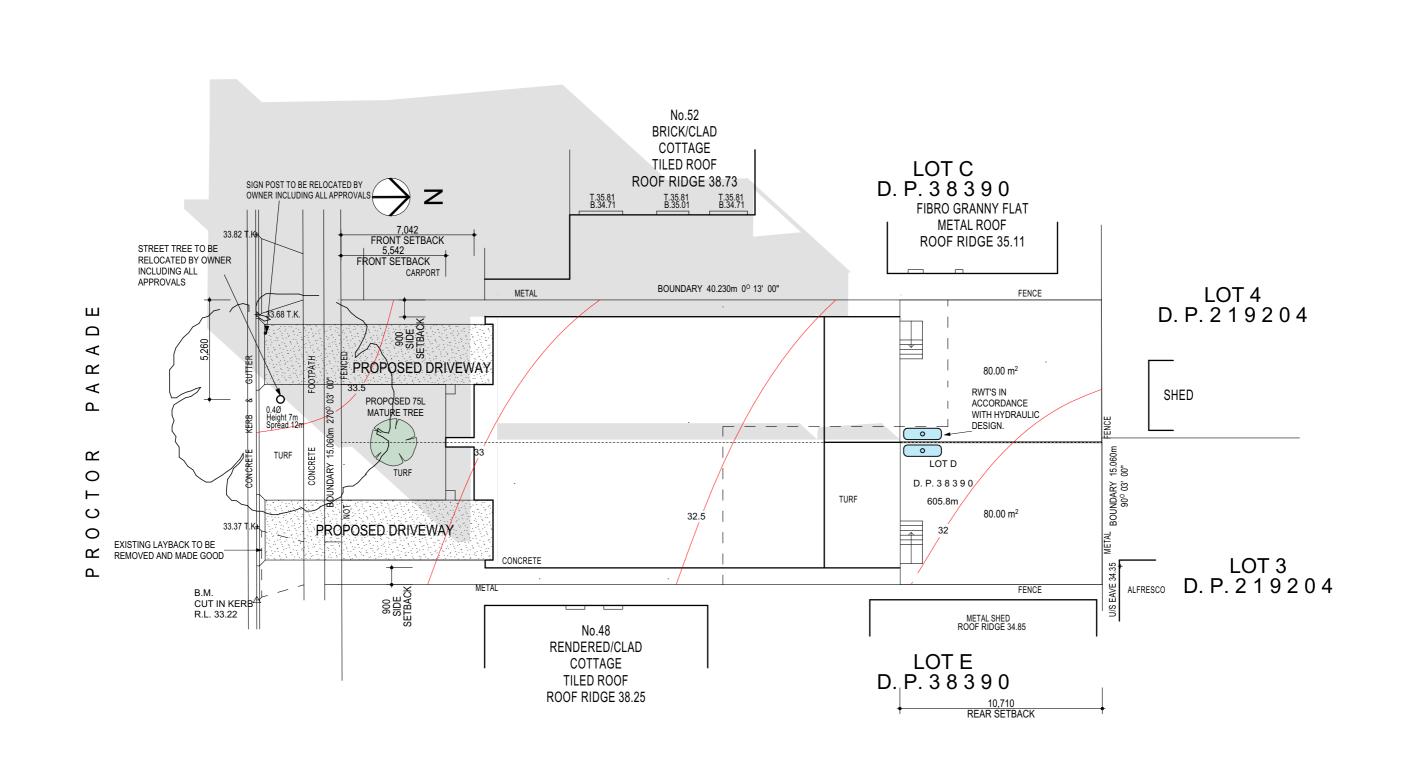

28/02/2023	FIRST ISSUE		A	
DATE		REVISION	ISSUE	

PROJECT NAME:
Proposed Duplex

DRAWING TITLE:
Shadow Diagram 9AM

DRAWN BY: JW CHECKED

CHECKED BY: LC

CLIENT NAME:
Tinh Dang

SITE DETAILS:
50 Proctor Parade, Chester Hill NSW

LOT NO: D SECT: - D P NO: 38390 SITE AREA: 605.8 m sq

LOT NO: D SECT: - D P NO: 38390 SITE AREA: 605


LGA: Canterbury - Bankstown Council ZONE: R2

PLOT DATE: 28/02/2023
PROJECT NO: 5727
SOFTWARE: ArchiCad V 24

ISSUE: A

SHEET NO: 9 of 15



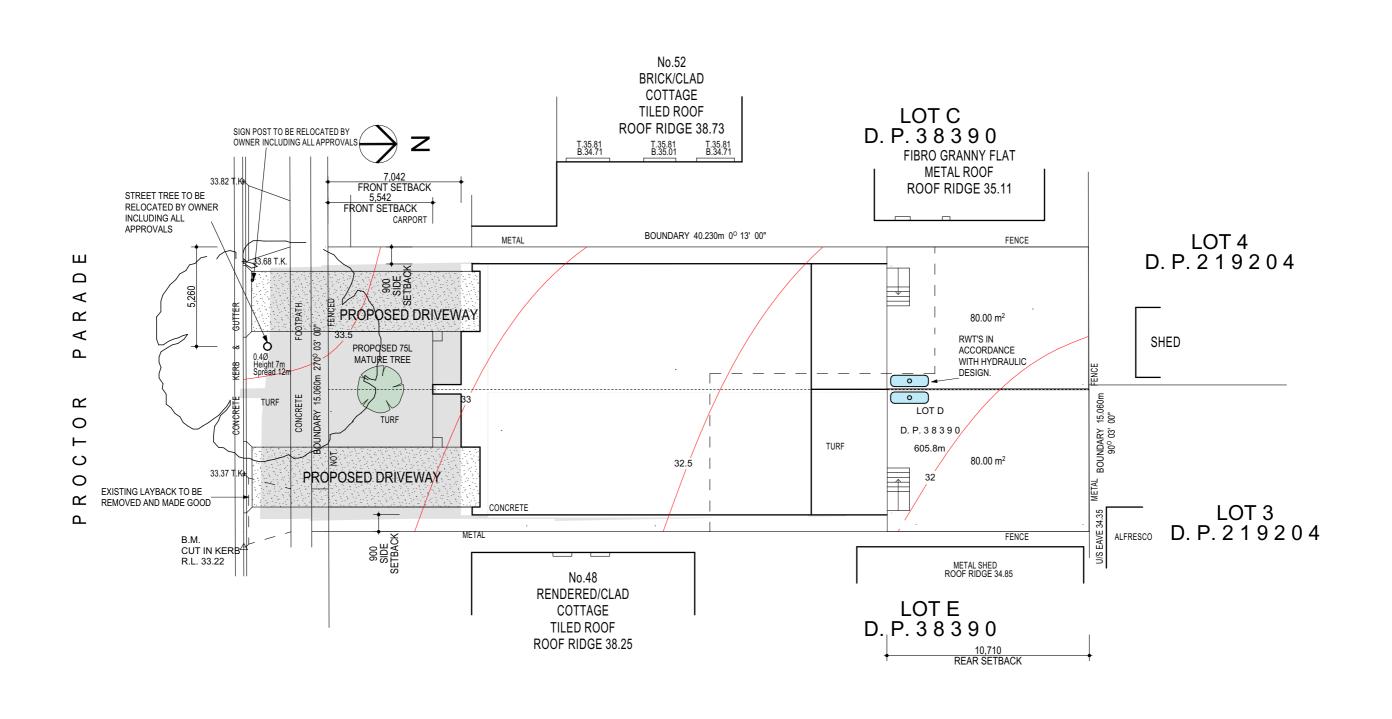

28/02/2023	FIRST ISSUE		Α	
DATE		REVISION	ISSUE	

PROJECT NAME: **Proposed Duplex** DRAWING TITLE: Shadow Diagram 12pm

CHECKED BY: LC DRAWN BY: JW

CLIENT NAME: Tinh Dang SITE DETAILS: 50 Proctor Parade, Chester Hill NSW

LOT NO: D SECT: - DP NO: 38390 SITE AREA: 605.8 m sq LGA: Canterbury - Bankstown Council


PLOT DATE: 28/02/2023 PROJECT NO: 5727 SOFTWARE: ArchiCad V 24

ISSUE:

SHEET NO: 10 of 15

ZONE: R2



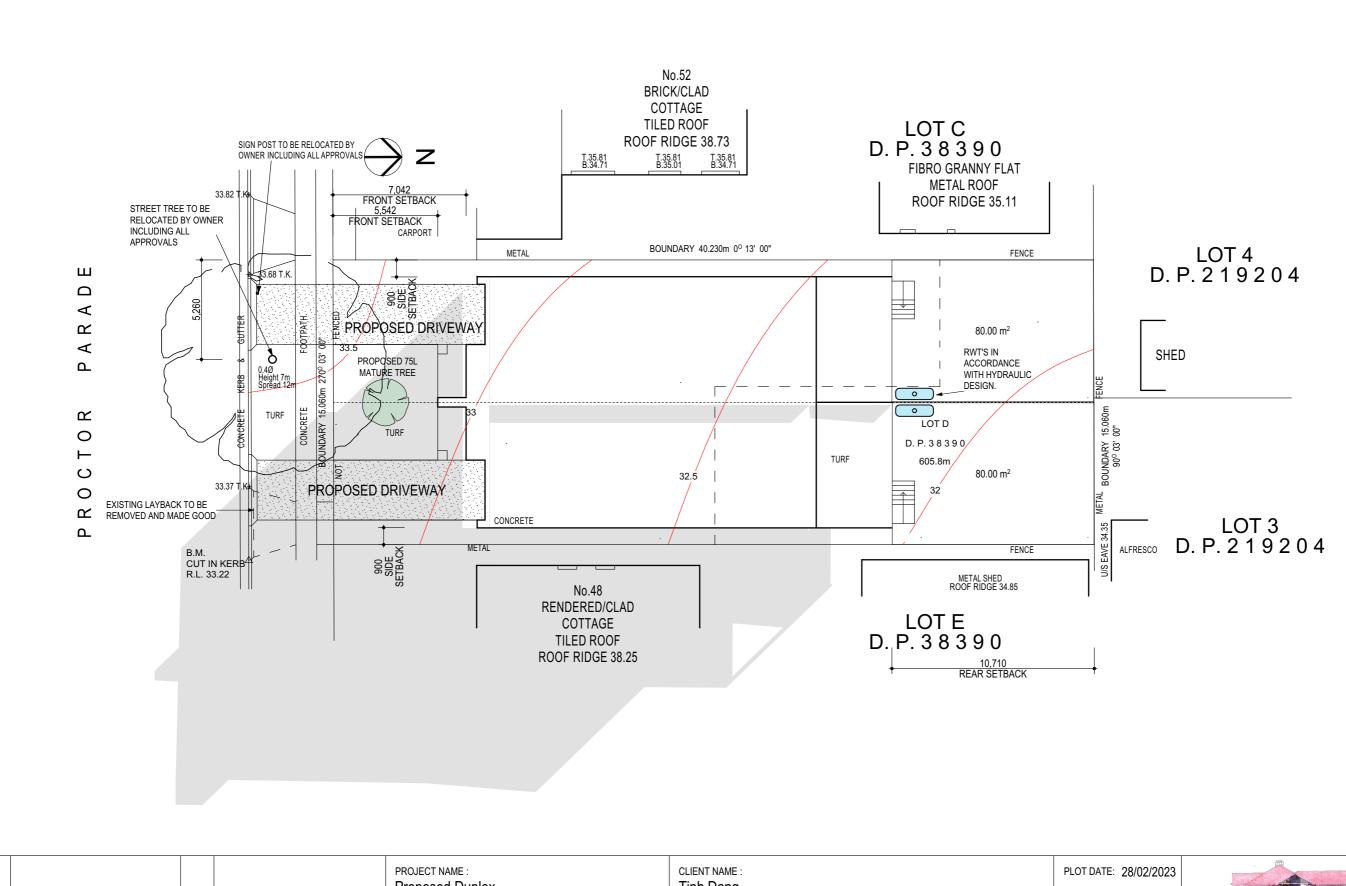

 28/02/2023
 FIRST ISSUE
 A

 DATE
 REVISION
 ISSUE

PROJECT NAME:
Proposed Duplex
DRAWING TITLE:
Shadow Diagram 3pm

DRAWN BY: JW CHECKED BY: LC

CLIENT NAME:
Tinh Dang
SITE DETAILS:
50 Proctor Parade, Chester Hill NSW

LOT NO: D SECT: - D P NO: 38390 SITE AREA: 605.8 m sq LGA: Canterbury - Bankstown Council ZONE: R2



PROJECT NO: 5727

ISSUE:

SOFTWARE: ArchiCad V 24

SHEET NO: 11 of 15

ABN : 21 003 757 444 **P** (02) 46 772 489 **E** mail@abodedrafting.com.au



Single Dwelling

Certificate number: 1352667S

This certificate confirms that the proposed development will meet the NSW government's requirements for sustainability, if it is built in accordance with the commitments set out below. Terms used in this certificate, or in the commitments, have the meaning given by the document entitled "BASIX Definitions" dated 10/09/2020 published by the Department. This document is available at

Secretary
Date of issue: Tuesday, 28 February 2023
To be valid, this certificate must be lodged within 3 months of the date of issue.



Project summary				
Project name	Proctor Parade Unit 1			
Street address	50 Proctor Parade Chester Hill 2162			
Local Government Area	Canterbury-Bankstown Council			
Plan type and plan number	deposited 83890			
Lot no.	D			
Section no.	- separate dwelling house			
Project type				
No. of bedrooms	4			
Project score				
Water	✓ 45 Target 40			
Thermal Comfort	✓ Pass Target Pass			
Energy	✓ 50 Target 50			

Certificate Prepared by
Name / Company Name: Abode Drafting
ABN (if applicable): 21 003 757 444

BASIX Planning, Industry & Environment www.basix.nsw.gov.au Version: 3.0 / DARWINIA_3_20_0 Certificate No.: 1352667S Tuesday, 28 February 2023

Description of project

Project address		
Project name	Proctor Parade Unit 1	
Street address	50 Proctor Parade Chester Hill 2162	
Local Government Area	Canterbury-Bankstown Council	
Plan type and plan number	Deposited Plan 83890	
Lot no.	D	
Section no.	-	
Project type		
Project type	separate dwelling house	
No. of bedrooms	4	
Site details		
Site area (m²)	606	
Roof area (m²)	150	
Conditioned floor area (m2)	181.92	
Unconditioned floor area (m2)	13.18	
Total area of garden and lawn (m2)	107	

Assessor details and thermal loads					
Assessor number	n/a				
Certificate number	n/a				
Climate zone	n/a				
Area adjusted cooling load (MJ/m².year)	n/a				
Area adjusted heating load (MJ/m².year)	n/a				
Ceiling fan in at least one bedroom	n/a				
Ceiling fan in at least one living room or other conditioned area	n/a				
Project score					
Water	✓ 45	Target 40			
Thermal Comfort	✓ Pass	Target Pass			
Energy	✓ 50	Target 50			

BASIX Planning, Industry & Environment www.basix.nsw.gov.au Version: 3.0 / DARWINIA_3_20_0 Certificate No.: 1352667S Tuesday, 28 February 2023

Schedule of BASIX commitments

The commitments set out below regulate how the proposed development is to be carried out. It is a condition of any development consent granted, or complying development certificate issued, for the proposed development, that BASIX commitments be complied with.

Water Commitments	Show on DA plans	Show on CC/CDC plans & specs	Certifier check			
Fixtures						
The applicant must install showerheads with a minimum rating of 3 star (> 7.5 but <= 9 L/min) in all showers in the development.		~	-			
The applicant must install a toilet flushing system with a minimum rating of 3 star in each toilet in the development.		~	-			
The applicant must install taps with a minimum rating of 3 star in the kitchen in the development.		~				
The applicant must install basin taps with a minimum rating of 3 star in each bathroom in the development.		~				
Alternative water						
Rainwater tank						
The applicant must install a rainwater tank of at least 3000 litres on the site. This rainwater tank must meet, and be installed in accordance with, the requirements of all applicable regulatory authorities.	~	~	~			
The applicant must configure the rainwater tank to collect rain runoff from at least 146 square metres of the roof area of the development (excluding the area of the roof which drains to any stormwater tank or private dam).		~	~			
development (excluding the area of the roof which drains to any stormwater tank or private dam).						
The applicant must connect the rainwater tank to:						
		~	-			
The applicant must connect the rainwater tank to:		· ·	~			

Thermal Comfort Commitments	Show on DA plans	Show on CC/CDC plans & specs	Certifier check
General features			
The dwelling must not have more than 2 storeys.	~	~	~
The conditioned floor area of the dwelling must not exceed 300 square metres.	~	~	-
The dwelling must not contain open mezzanine area exceeding 25 square metres.	~	~	~
The dwelling must not contain third level habitable attic room.	~	~	~
Floor, walls and ceiling/roof			
The applicant must construct the floor(s), walls, and ceiling/roof of the dwelling in accordance with the specifications listed in the table below.	-	_	-

Construction	Additional insulation required (R-Value)	Other specifications
floor - concrete slab on ground	nil	
external wall - brick veneer	1.86 (or 2.40 including construction)	
internal wall shared with garage - plasterboard	nil	
ceiling and roof - flat ceiling / flat roof, framed	ceiling: 4.5 (up), roof: foil backed blanket (75 mm)	framed; medium (solar absorptance 0.475-0.70)

Note • Insulation specified in this Certificate must be installed in accordance with Part 3.12.1.1 of the Building Code of Australia.

Note • In some climate zones, insulation should be installed with due consideration of condensation and associated interaction with adjoining building materials.

BASIX Planning, Industry & Environment www.basix.nsw.gov.au Version: 3.0 / DARWINIA_3_20_0 Certificate No.: 1352667S Tuesday, 28 February 2023

BASIX Planning, Industry & Environment www.basix.nsw.gov.au Version: 3.0 / DARWINIA_3_20_0

Certificate No.: 1352667S Tuesday, 28 February 2023

28/02/2023	FIRST ISSUE	Α	
DATE	REVISION	ISSUE	

PROJECT NAME: Proposed Duplex

DRAWING TITLE : Basix Unit 1

DRAWN BY: JW

CHECKED BY: LC

CLIENT NAME: Tinh Dang

SITE DETAILS:

50 Proctor Parade, Chester Hill NSW

LOT NO: D SECT: - DP NO: 38390 LGA: Canterbury - Bankstown Council

SITE AREA: 605.8 m sq

ZONE: R2

PLOT DATE: 28/02/2023 PROJECT NO: 5727 SOFTWARE: ArchiCad V 24

ISSUE:

SHEET NO: 12 of 15



Thermal Comfort Commitments	Show on DA plans	Show on CC/CDC plans & specs	Certifier check
Windows, glazed doors and skylights			
The applicant must install the windows, glazed doors and shading devices described in the table below, in accordance with the specifications listed in the table. Relevant overshadowing specifications must be satisfied for each window and glazed door.	~	~	-
The dwelling may have 1 skylight (<0.7 square metres) which is not listed in the table.		~	-
The following requirements must also be satisfied in relation to each window and glazed door:	~	~	~
For the following glass and frame types, the certifier check can be performed by visual inspection.			-
- Aluminium single clear			
- Aluminium double (air) clear			
- Timber/uPVC/fibreglass single clear			
- Timber/uPVC/fibreglass double (air) clear			

Window/glazed door no.	Maximum height (mm)	Maximum width (mm)	Туре	Shading Device (Dimension within 10%)	Overshadowing
North facing					
U1 - D2	2100	4780	aluminium, single, clear	verandah 4000 mm, 2578 mm above base of window or glazed door	not overshadowed
U1 - W06	600	2170	aluminium, single, clear	none	not overshadowed
U1 - W07	600	2170	aluminium, single, clear	none	not overshadowed
East facing					
U1 - W02	1460	2170	aluminium, single, clear	none	not overshadowed
U1 - W03	600	2170	aluminium, single, clear	none	not overshadowed
U1 - W04	1460	1210	aluminium, single, clear	none	not overshadowed
U1 - W08	600	2170	aluminium, single, clear	none	not overshadowed
U1 - W09	600	850	aluminium, single, clear	none	not overshadowed
U1 - W10	600	850	aluminium, single, clear	none	not overshadowed

ASIX Planning, Industry & Environment www.basix.nsw.gov.au Version: 3.0 / DARWINIA, 3, 20_0 Certificate No.: 135/266/S Tuesday, 28 February 2023 page 5/

Energy Commitments	Show on DA plans	Show on CC/CDC plans & specs	Certifier check
Hot water			
The applicant must install the following hot water system in the development, or a system with a higher energy rating: gas instantaneous with a performance of 3 stars.	~	✓	~
Cooling system			
The applicant must install the following cooling system, or a system with a higher energy rating, in at least 1 living area: airconditioning ducting only; Energy rating: n/a		~	~
The applicant must install the following cooling system, or a system with a higher energy rating, in at least 1 bedroom: airconditioning ducting only; Energy rating: n/a		~	~
Heating system			
The applicant must install the following heating system, or a system with a higher energy rating, in at least 1 living area: airconditioning ducting only; Energy rating: n/a		~	_
The applicant must install the following heating system, or a system with a higher energy rating, in at least 1 bedroom: airconditioning ducting only; Energy rating: n/a		~	~
Ventilation			
The applicant must install the following exhaust systems in the development:			
At least 1 Bathroom: individual fan, not ducted; Operation control: manual switch on/off		~	-
Kitchen: individual fan, not ducted; Operation control: manual switch on/off		~	-
Laundry: individual fan, not ducted; Operation control: manual switch on/off		✓	-
Artificial lighting			
The applicant must ensure that the 'primary type of artificial lighting' is fluorescent or light emitting diode (LED) lighting in each of the following rooms, and where the word 'dedicated' appears, the fittings for those lights must only be capable of accepting fluorescent or light emitting dole (LED) lamps:			
at least 4 of the bedrooms / study; dedicated		•	-
at least 2 of the living / dining rooms; dedicated		•	-
the kitchen; dedicated			

Window/glazed door no.	Maximum height (mm)	Maximum width (mm)	Туре	Shading Device (Dimension within 10%)	Overshadowing
U1 - W11	1460	2170	aluminium, single, clear	none	not overshadowed
South facing					
U1 - D1	2143	1080	aluminium, single, clear	verandah 1500 mm, 3000 mm above base of window or glazed door	not overshadowed
U1 - W01	2143	610	aluminium, single, clear	verandah 1500 mm, 3000 mm above base of window or glazed door	not overshadowed
U1 - D3	2400	2410	aluminium, single, clear	eave 1200 mm, 385 mm above head of window or glazed door	not overshadowed
U1 - W05	1460	1570	aluminium, single, clear	eave 200 mm, 385 mm above head of window or glazed door	not overshadowed

Energy Commitments	Show on DA plans	Show on CC/CDC plans & specs	Certifier check
all bathrooms/toilets; dedicated		~	~
the laundry; dedicated		•	-
all hallways; dedicated		•	-
Natural lighting			
The applicant must install a window and/or skylight in 3 bathroom(s)/toilet(s) in the development for natural lighting.	~	~	~
Other			
The applicant must install a gas cooktop & electric oven in the kitchen of the dwelling.		~	
The applicant must construct each refrigerator space in the development so that it is "well ventilated", as defined in the BASIX definitions.		~	
The applicant must install a fixed outdoor clothes drying line as part of the development.			

In the Second interments, approach the development, application for the proposed development (if a development application is to be lodged for the proposed development).

Commitments identified with a win the "Show on DCICDC plans and specs" column must be shown in the plans and specifications accompanying the application for a construction certificate / complying development certificate for the proposed development.

Commitments identified with a win the "Show on CCICDC plans and specs" column must be shown in the plans and specifications accompanying the application for a construction certificate / complying development certificate for the proposed development.

Commitments identified with a win the "Certifier check" column must be certified by a certifying authority as having been fulfilled, before a final occupation certificate(either interim or final) for the development may be issued.

28/02/2023	FIRST ISSUE		A	
DATE	REVISI	ON	ISSUE	

PROJECT NAME:
Proposed Duplex
DRAWING TITLE:
Basix Unit 1

DRAWN BY: JW

CHECKED BY: LC

CLIENT NAME:
Tinh Dang
SITE DETAILS:
50 Proctor Parade, Chester Hill NSW

LOT NO: D SECT: - D P NO: 38390 SITE AREA: 605.8 m sq LGA: Canterbury - Bankstown Council ZONE: R2 PLOT DATE: 28/02/2023
PROJECT NO: 5727
SOFTWARE: ArchiCad V 24

ISSUE: A

SHEET NO: 13 of 15





Single Dwelling

Certificate number: 1352741S

This certificate confirms that the proposed development will meet the NSW government's requirements for sustainability, if it is built in accordance with the commitments set out below. Terms used in this certificate, or in the commitments, have the meaning given by the document entitled "BASIX Definitions" dated 10/09/2020 published by the Department. This document is available at

Secretary
Date of issue: Tuesday, 28 February 2023
To be valid, this certificate must be lodged within 3 months of the date of issue.



Project summary		
Project name	Proctor Parade unit 2	
Street address	50 Proctor Parade Chester Hill 2162	
Local Government Area	Canterbury-Bankstown Council	
Plan type and plan number deposited 83890		
Lot no.	D	
Section no.	-	
Project type	separate dwelling house	
No. of bedrooms	4	
Project score		
Water	✓ 45 Target 40	
Thermal Comfort	✓ Pass Target Pass	
Energy	✓ 50 Target 50	

Certificate Prepared by	
Name / Company Name: Abode Drafting	1
ABN (if applicable): 21 003 757 444	1

BASIX Planning, Industry & Environment www.basix.nsw.gov.au Version: 3.0 / DARWINIA_3_20_0 Certificate No.: 1352741S Tuesday, 28 February 2023

Description of project

Project address	
Project name	Proctor Parade unit 2
Street address	50 Proctor Parade Chester Hill 2162
Local Government Area	Canterbury-Bankstown Council
Plan type and plan number	Deposited Plan 83890
Lot no.	D
Section no.	-
Project type	
Project type	separate dwelling house
No. of bedrooms	4
Site details	
Site area (m²)	606
Roof area (m²)	150
Conditioned floor area (m2)	181.92
Unconditioned floor area (m2)	13.18
Total area of garden and lawn (m2)	107

Assessor details and thermal lo	ads	
Assessor number	n/a	
Certificate number	n/a	
Climate zone	n/a	
Area adjusted cooling load (MJ/m².year)	n/a	
Area adjusted heating load (MJ/m².year)	n/a	
Ceiling fan in at least one bedroom	n/a	
Ceiling fan in at least one living room or other conditioned area	n/a	
Project score		
Water	✓ 45	Target 40
Thermal Comfort	✓ Pass	Target Pass
Energy	✓ 50	Target 50

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Schedule of BASIX commitments

The commitments set out below regulate how the proposed development is to be carried out. It is a condition of any development consent granted, or complying development certificate issued, for the proposed development, that BASIX commitments be compiled with.

Water Commitments	Show on DA plans	Show on CC/CDC plans & specs	Certifier check
Fixtures			
The applicant must install showerheads with a minimum rating of 3 star (> 7.5 but <= 9 L/min) in all showers in the development.		~	-
The applicant must install a toilet flushing system with a minimum rating of 3 star in each toilet in the development.		~	-
The applicant must install taps with a minimum rating of 3 star in the kitchen in the development.		~	
The applicant must install basin taps with a minimum rating of 3 star in each bathroom in the development.		~	
Alternative water			
Rainwater tank			
The applicant must install a rainwater tank of at least 3000 litres on the site. This rainwater tank must meet, and be installed in accordance with, the requirements of all applicable regulatory authorities.		~	-
accordance with, the requirements of all applicable regulatory authorities. The applicant must configure the rainwater tank to collect rain runoff from at least 146 square metres of the roof area of the	~	· ·	~
accordance with, the requirements of all applicable regulatory authorities. The applicant must configure the rainwater tank to collect rain runoff from at least 146 square metres of the roof area of the development (excluding the area of the roof which drains to any stormwater tank or private dam).	•	· ·	~
	•	· ·	· ·
accordance with, the requirements of all applicable regulatory authorities. The applicant must configure the rainwater tank to collect rain runoff from at least 146 square metres of the roof area of the development (excluding the area of the roof which drains to any stormwater tank or private dam). The applicant must connect the rainwater tank to:	~	· · ·	· · · · ·

Thermal Comfort Commitments	Show on DA plans	Show on CC/CDC plans & specs	Certifier check
General features			
The dwelling must not have more than 2 storeys.	~	~	~
The conditioned floor area of the dwelling must not exceed 300 square metres.	~	~	~
The dwelling must not contain open mezzanine area exceeding 25 square metres.	~	~	~
The dwelling must not contain third level habitable attic room.	~	~	~
Floor, walls and ceiling/roof			
The applicant must construct the floor(s), walls, and ceiling/roof of the dwelling in accordance with the specifications listed in the table below.	~	~	-

Construction	Additional insulation required (R-Value)	Other specifications
floor - concrete slab on ground	nil	
external wall - brick veneer	1.86 (or 2.40 including construction)	
internal wall shared with garage - plasterboard	nil	
ceiling and roof - flat ceiling / flat roof, framed	ceiling: 4.5 (up), roof: foil backed blanket (75 mm)	framed; medium (solar absorptance 0.475-0.70)

Note • Insulation specified in this Certificate must be installed in accordance with Part 3.12.1.1 of the Building Code of Australia. Note • In some climate zones, insulation should be installed with due consideration of condensation and associated interaction with adjoining building materials.

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Certificate No.: 1352741S Tuesday, 28 February 2023

28/02/2023	FIRST ISSUE		Α	
DATE	F	REVISION	ISSUE	

PROJECT NAME : Proposed Duplex

DRAWING TITLE : Basix Unit 2

DRAWN BY: JW

CHECKED BY: LC

CLIENT NAME: Tinh Dang

SITE DETAILS:

50 Proctor Parade, Chester Hill NSW

LOT NO: D SECT: - DP NO: 38390 LGA: Canterbury - Bankstown Council

SITE AREA: 605.8 m sq ZONE: R2

PLOT DATE: 28/02/2023 PROJECT NO: 5727 SOFTWARE: ArchiCad V 24

ISSUE:

SHEET NO: 14 of 15



Thermal Comfort Commitments	Show on DA plans	Show on CC/CDC plans & specs	Certifier check
Windows, glazed doors and skylights			
The applicant must install the windows, glazed doors and shading devices described in the table below, in accordance with the specifications listed in the table. Relevant overshadowing specifications must be satisfied for each window and glazed door.	~	~	~
The dwelling may have 1 skylight (<0.7 square metres) which is not listed in the table.	~	~	~
The following requirements must also be satisfied in relation to each window and glazed door:	~	V	~
For the following glass and frame types, the certifier check can be performed by visual inspection.			-
- Aluminium single clear			
- Aluminium double (air) clear			
- Timber/uPVC/fibreglass single clear			
- Timber/uPVC/fibreglass double (air) clear			

Window/glazed door no.	Maximum height (mm)	Maximum width (mm)	Туре	Shading Device (Dimension within 10%)	Overshadowing
North facing					
U2 - D2	2100	4780	aluminium, single, clear	verandah 4000 mm, 2578 mm above base of window or glazed door	not overshadowed
U2 - W07	600	2170	aluminium, single, clear	none	not overshadowed
U2 - W06	600	2170	aluminium, single, clear	none	not overshadowed
South facing					
U2 - D1	2143	1080	aluminium, single, clear	verandah 1500 mm, 3000 mm above base of window or glazed door	not overshadowed
U2 - W01	2143	610	aluminium, single, clear	verandah 1500 mm, 3000 mm above base of window or glazed door	not overshadowed
U2 - W05	1460	1570	aluminium, single, clear	eave 200 mm, 385 mm above head of window or glazed door	not overshadowed
U2 - D3	2400	2410	aluminium, single, clear	eave 1200 mm, 385 mm above head of window or glazed door	not overshadowed

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Energy Commitments	Show on DA plans	Show on CC/CDC plans & specs	Certifier check
Hot water			
The applicant must install the following hot water system in the development, or a system with a higher energy rating: gas instantaneous with a performance of 3 stars.	~	~	~
Cooling system			
The applicant must install the following cooling system, or a system with a higher energy rating, in at least 1 living area: airconditioning ducting only; Energy rating: n/a		~	~
The applicant must install the following cooling system, or a system with a higher energy rating, in at least 1 bedroom: airconditioning ducting only; Energy rating: n/a		~	~
Heating system			
The applicant must install the following heating system, or a system with a higher energy rating, in at least 1 living area: airconditioning ducting only; Energy rating: n/a		~	~
The applicant must install the following heating system, or a system with a higher energy rating, in at least 1 bedroom: airconditioning ducting only; Energy rating: n/a		~	~
Ventilation			
The applicant must install the following exhaust systems in the development:			
At least 1 Bathroom: individual fan, not ducted; Operation control: manual switch on/off		La Car	
Kitchen: individual fan, not ducted; Operation control: manual switch on/off		•	_
Nichen, Individual fan, not ducted, Operation control. Manual switch onton		✓	V
Laundry: individual fan, not ducted; Operation control: manual switch on/off		~	-
Artificial lighting			
The applicant must ensure that the "primary type of artificial lighting" is fluorescent or light emitting diode (LED) lighting in each of the ollowing rooms, and where the word "dedicated" appears, the fittings for those lights must only be capable of accepting fluorescent or light emitting diode (LED) lamps:			
at least 4 of the bedrooms / study; dedicated			
at least 2 of the living / dining rooms; dedicated		_	_
- at reast 2 of the living / ultiling rooms, dedicated		~	-
the kitchen; dedicated			

DATE

REVISION

ISSUE

Window/glazed door no.	Maximum height (mm)	Maximum width (mm)	Туре	Shading Device (Dimension within 10%)	Overshadowing
West facing	,	,,		1000	
U2 - W10	600	850	aluminium, single, clear	none	not overshadowed
U2 - W03	600	2170	aluminium, single, clear	none	not overshadowed
U2 - W11	1460	2170	aluminium, single, clear	none	not overshadowed
U2 - W08	600	2170	aluminium, single, clear	none	not overshadowed
U2 - W02	1460	2170	aluminium, single, clear	none	not overshadowed
U2 - W09	600	850	aluminium, single, clear	none	not overshadowed
U2 - W04	1460	1210	aluminium, single, clear	none	not overshadowed

Energy Commitments	Show on DA plans	Show on CC/CDC plans & specs	Certifier check
all bathrooms/toilets; dedicated		~	~
the laundry; dedicated		•	-
all hallways; dedicated		V	-
Natural lighting			
The applicant must install a window and/or skylight in 3 bathroom(s)/toilet(s) in the development for natural lighting.	~	~	-
Other			
The applicant must install a gas cooktop & electric oven in the kitchen of the dwelling.		~	
The applicant must construct each refrigerator space in the development so that it is "well ventilated", as defined in the BASIX definitions.		~	
The applicant must install a fixed outdoor clothes drying line as part of the development.			

BASIX Planning Industry & Environment waver hasin new one as Version 3.0 (DARWINIA 3.20.0 Cardinate No. 1352741S Tuesday 28 Eshneav 2023

Legend

In these commitments, "applicant" means the person carrying out the development.

Commitments identified with a win the "Show on DA plans" column must be shown on the plans accompanying the development application for the proposed development (if a development application is to be lodged for the proposed development).

Commitments identified with a win the "Show on OC/CIDC plans and speess" column must be shown in the plans and specifications accompanying the application for a construction certificate / complying development certificate for the proposed development.

Commitments identified with a win the "Certifier check" column must be certified by a certifying authority as having been fulfilled, before a final occupation certificate(either interim or final) for the development may be issued.

PROJECT NAME:

CLIENT NAME:

Version: 3.0 / DARWINIA, 3_20_0
V

LGA: Canterbury - Bankstown Council

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